



FIRE CODE COMPLIANCE:
Fire code compliance with NZBC sections
C1/AS1, C2/AS1 C3/AS1 & C4/AS1.
Purpose group SH in accordance with

Proposed dwelling compliant with C1/AS1 Detached Dwelling: Paragraphs 1.3.3 &



### GENERAL NOTES:

1.3.4 - Pg 36

Table 2.1 Pg 43

Hot water pipes to be lagged to comply with NZBC H1/AS1 5.0

All dimensions are CRITICAL to ensure neat and exact fitting of components/fixtures.

Most important are Baths, Showers, Vanities and the like. Due to manufacturing processes these can vary in dimension + or - 5mm. Confirm ALL dimensions prior to placing Gib Board or before permanently fixing any items.

Ensure 'cabinatery and other components' backing nogs are placed prior to placing any wall linings.

N.I.C. = Not in Contract.

KEY WALL FRAMING:

### EXTERIOR WALLS

Allow 90x45 SG8 H1.2 KD studs @ 600mm ctrs with 2 rows of nogs.

### INTERIOR WALLS;

Allow 90x45 SG8 H1.2 KD studs @ 600mm ctrs with 2 rows of nogs.

90x45mm timber wall framing

Allow to rebate studs for recessing of bath.

Allow 10mm Gib Aqualine on ceiling and walls for all bathrooms & laundry.

### INSULATION:

Allow wall insulation of R2.2 Allow ceiling insulation of R3.2

NOTE: Refer to Placemakers pre-nail Producer statement for all lintel & beam sizes.

### **CUSTOM DESIGN**

Floor Area:

House

= 221.36m<sup>2</sup>

Garage

 $= 42.26m^2$ 

Total Floor Area = 263.62m<sup>2</sup> (o/frame)

All documentation prepared in accordance with NZS:3604:2011 [\*All timber stress grading to be SG8 unless otherwise noted.

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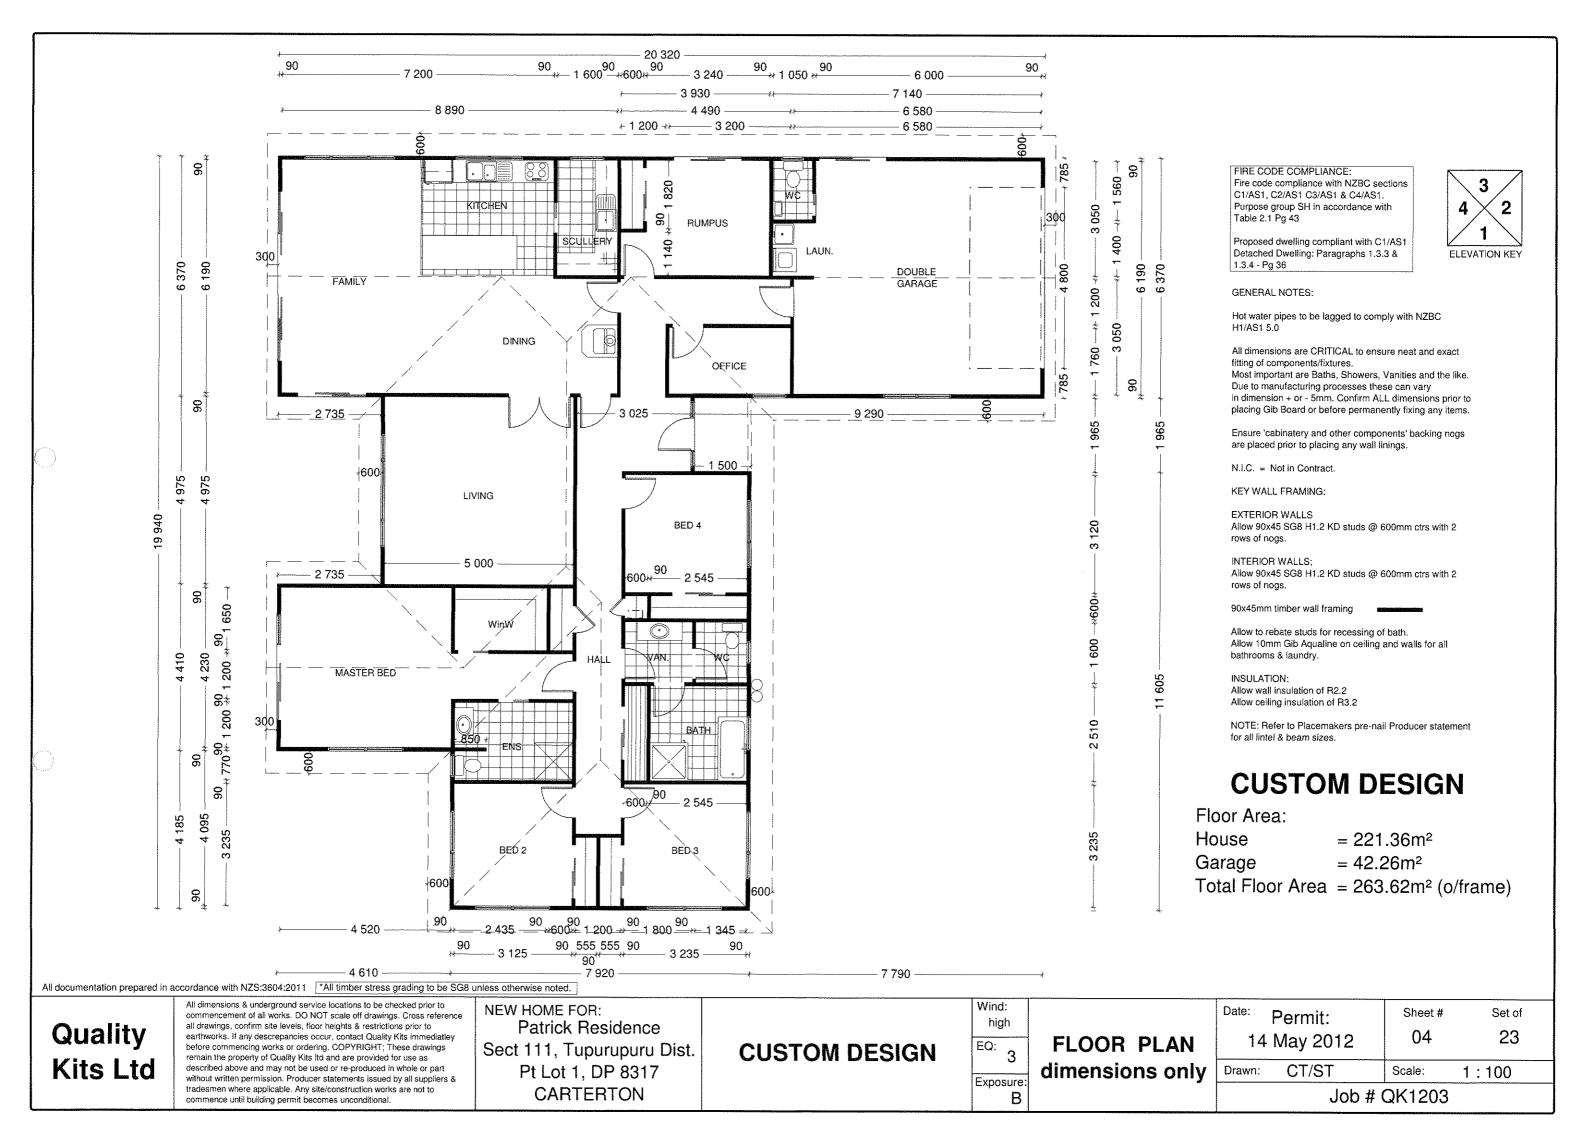
NEW HOME FOR:
Patrick Residence
Sect 111, Tupurupuru Dist.
Pt Lot 1, DP 8317
CARTERTON

CUSTOM DESIGN


Wind:
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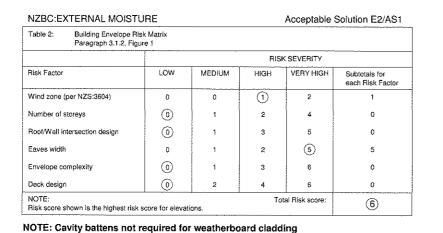
FLOOR PLAN texts only

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Date:	Permit:	Sheet #	Set of
14	May 2012	03	23
Drawn:	CT/ST	Scale:	1:100



All Window & Door joinery head heights to be 2.0m above finished flor level, except for entry door & s/light set at 2.05m



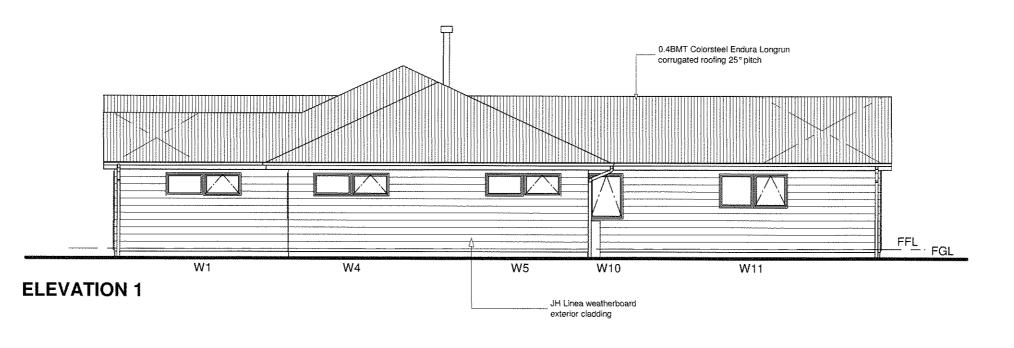

D1 D2 < 500 > 1000 × 1000


GLAZING SCHEDULE: sg = safety glass.

- S1 = Res. side panel of width > 500mm & lower edge < 500mm above highest abutting floor level = Grade 'A' Safety Glass.
- S2 = Res. side panel of width < 500mm = Annealed Glass.
- S3 = Res. side panel of width > 1000mm = Grade 'A' Safety Glass.
- S4 = Res. side panel of width < 1000mm = Annealed Glass.
- S5 = Res. side panel with transom = Annealed Glass.
- D1 = Hinged door with panels of area > 0.5m2 = Grade 'A' Safety Glass.
- D2 = Hinged door with panels of area < 0.5m2 = Annealed Glass.
- D3 = Hinged door with panels of area > 0.5m2 = Grade 'A' Safety Glass.
- D4 = Hinged door with transom = Annealed Glass.

All glazing below 1000mm height in access routes (including stairwells) to be

All glazing to be in accordance with NZS.4223.

ALL GLAZING TO BE DOUBLE GLAZED EXCEPT FOR JOINERY TO GARAGE

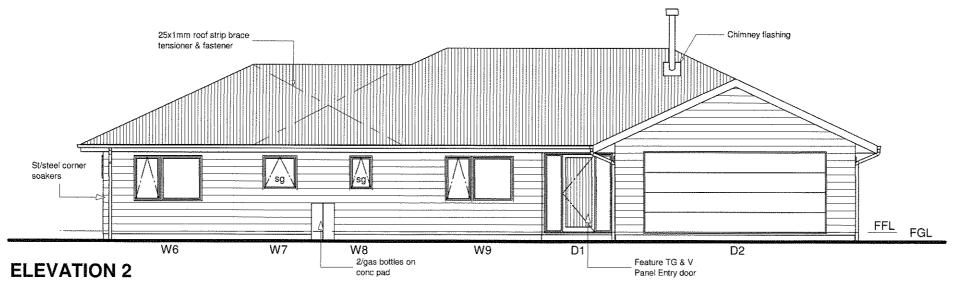

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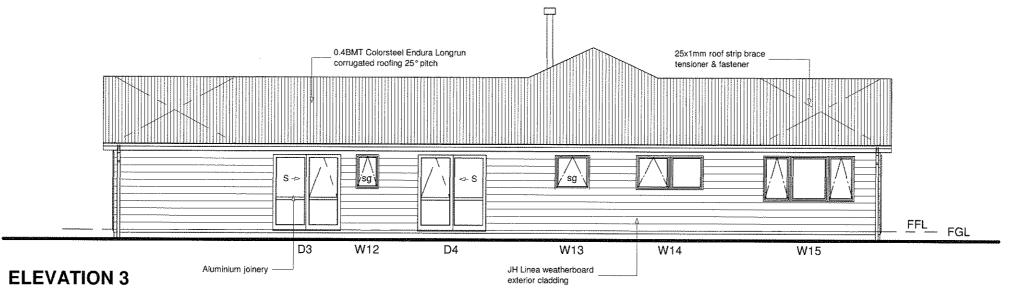
**CUSTOM DESIGN** 

Wind: high EQ: Exposure:

**ELEVATIONS** 


Sheet # Set of Permit: 05 14 May 2012 CT/ST Scale: 1:100

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NZBC:EXTERNAL MOISTURE Acceptable Solution E2/AS1 Building Envelope Risk Matrix Paragraph 3.1.2, Figure 1 RISK SEVERITY Risk Factor LOW MEDIUM VERY HIGH HIGH Subtotals for each Risk Factor Wind zone (per NZS:3604) 1 0 0 (5) Eaves width 0 Envelope complexity Deck design 6 Risk score shown is the highest risk score for elevations

NOTE: Cavity battens not required for weatherboard cladding



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D2 = Hinged door with panels of area < 0.5m2 = Annealed Glass.

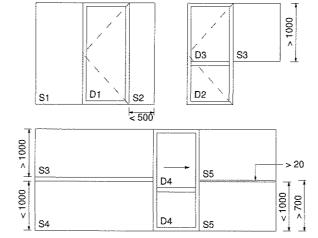
D3 = Hinged door with panels of area > 0.5m<sup>2</sup> = Grade 'A' Safety Glass.

D4 = Hinged door with transom = Annealed Glass.

All glazing below 1000mm height in access routes (including stairwells) to be Grade 'A' Safety Glass.

All glazing to be in accordance with NZS.4223.

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**CUSTOM DESIGN** 

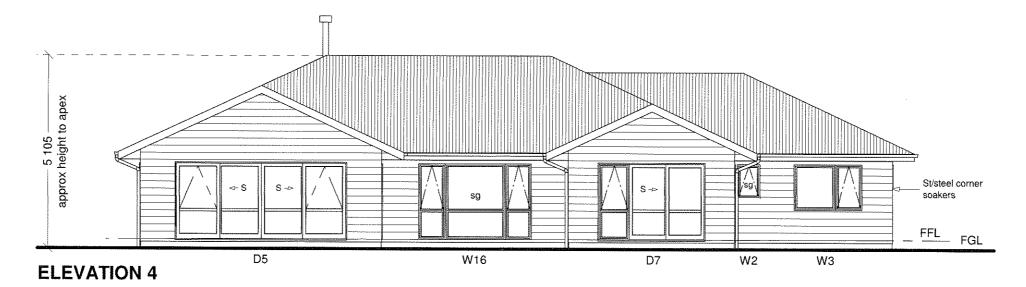
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**ELEVATIONS** 

Permit: 14 May 2012 CT/ST

Sheet # Set of 23 06

Scale: 1:100

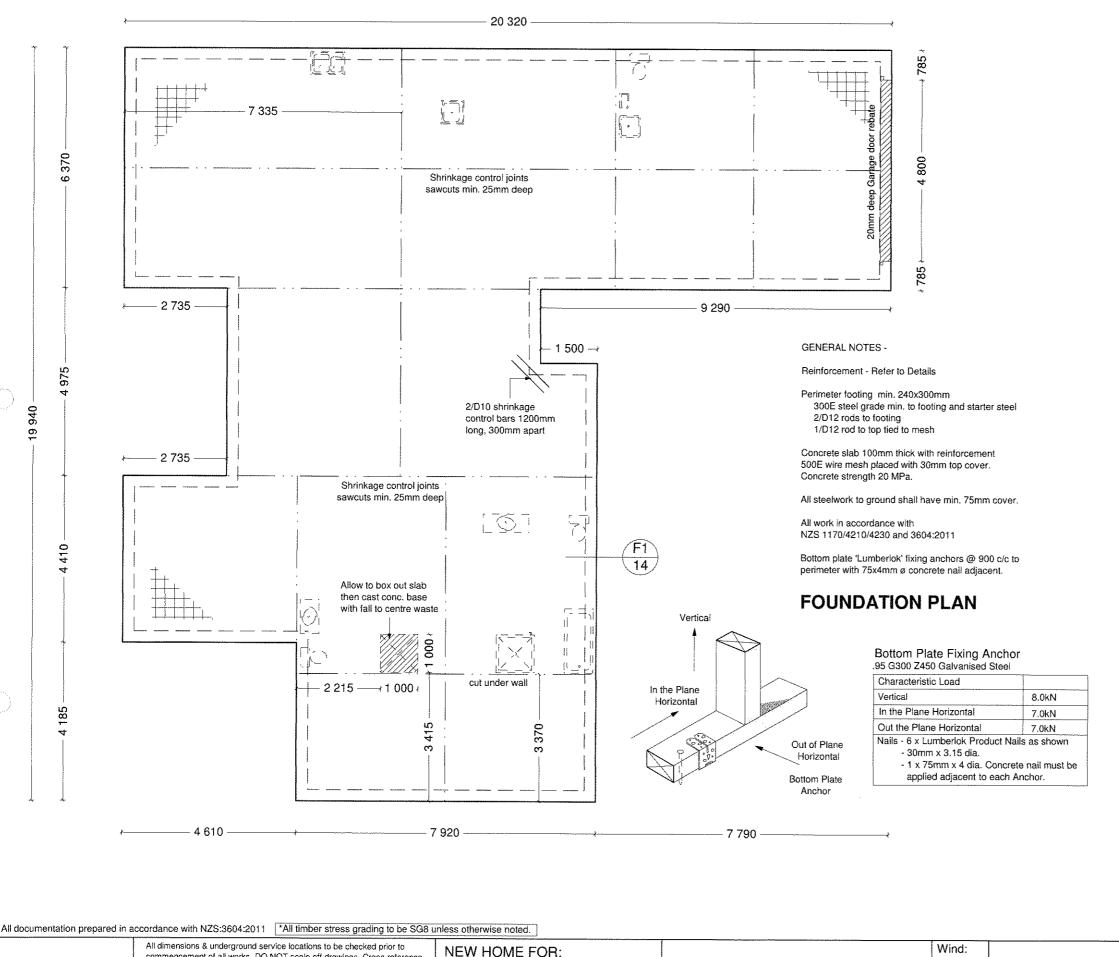

### SLAB / FOUNDATION NOTES:

The slab system shall be laid over an excavated area providing minimum ultimate bearing capacity of 300KPa.

Provide compacted granular fill as required to suit level for min. 5 -25mm max compacted sand blinding.

Lay DPC moistop 150 over sand blinding fully sealed at sheet joints & any punctured areas & extended beyond footing edges.

Perimeter boxing to the foundation slab shall be solid & fully braced to ensure a true & even edge is maintained. Any excessive deviation of the finished line shall be made good at the contractors expense. The contractor shall allow for all slab edge rebates as indicated & the laying of in-slab plumbing lines fully wrapped in 'Denso' tape to allow for thermal movement. No water supply pipework shall be cast into the

The contractor shall liase with subtrades to co-ordinate the position & provision of incoming services.

Slab thickenings (if required) under load bearing walls shall be a minimum width of 250mm wide centred under these partitions.

#### NOTES:

All aspects of this project, once completed, must fully comply with all statutory requirements, Territorial Authority requirements, the relevant provisions of the New Zealand Building Code and New Zealand Standards irrespective of whether or not detailed in these plans and

All proprietary products are to be selected and installed in strict accordance with the Manufacturers specifications. A registered surveyor shall be used to setout & certify the foundations

and floor if required by the Territorial Authority Remove all topsoil and organic matter from within the perimeter of the

footings and slab work. The finished ground level surrounding the building shall have a fall of 1:25 away from the building for min. 1.0 m.

Allow for an Engineers certificate to be provided to the Territorial Authority if requested for granular fill 600mm or more.

### PLUMBING NOTES:

Plumbing services to be plumbed in accordance with NZBC G13/AS1.

All foulwater pipework shall be from approved proprietary Upvc material including all accessories all to conform with NZBC durability

5 years - all exposed piping & valves

15 years - all concealed works with no provision for access / maintenance.

50 years - all pipework cast into concrete slabs.

All pipework cast into concrete slab shall be wrapped in 'Denso' tape to provide for adequate thermal movement.

All water supply pipework shall be approved proprietary polybutylene with associated proprietary accessories. All NZBC:B2/AS1 Durability requirements as listed above.

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commencement of all works. DO NOT scale off drawings, Cross reference all drawings, confirm site levels, floor heights & restrictions prior to earthworks. If any descrepancies occur, contact Quality Kits immediately before commencing works or ordering. COPYRIGHT; These drawings remain the property of Quality Kits Itd and are provided for use as described above and may not be used or re-produced in whole or part without written permission. Producer statements issued by all suppliers & tradesmen where applicable. Any site/construction works are not to commence until building permit becomes unconditional.

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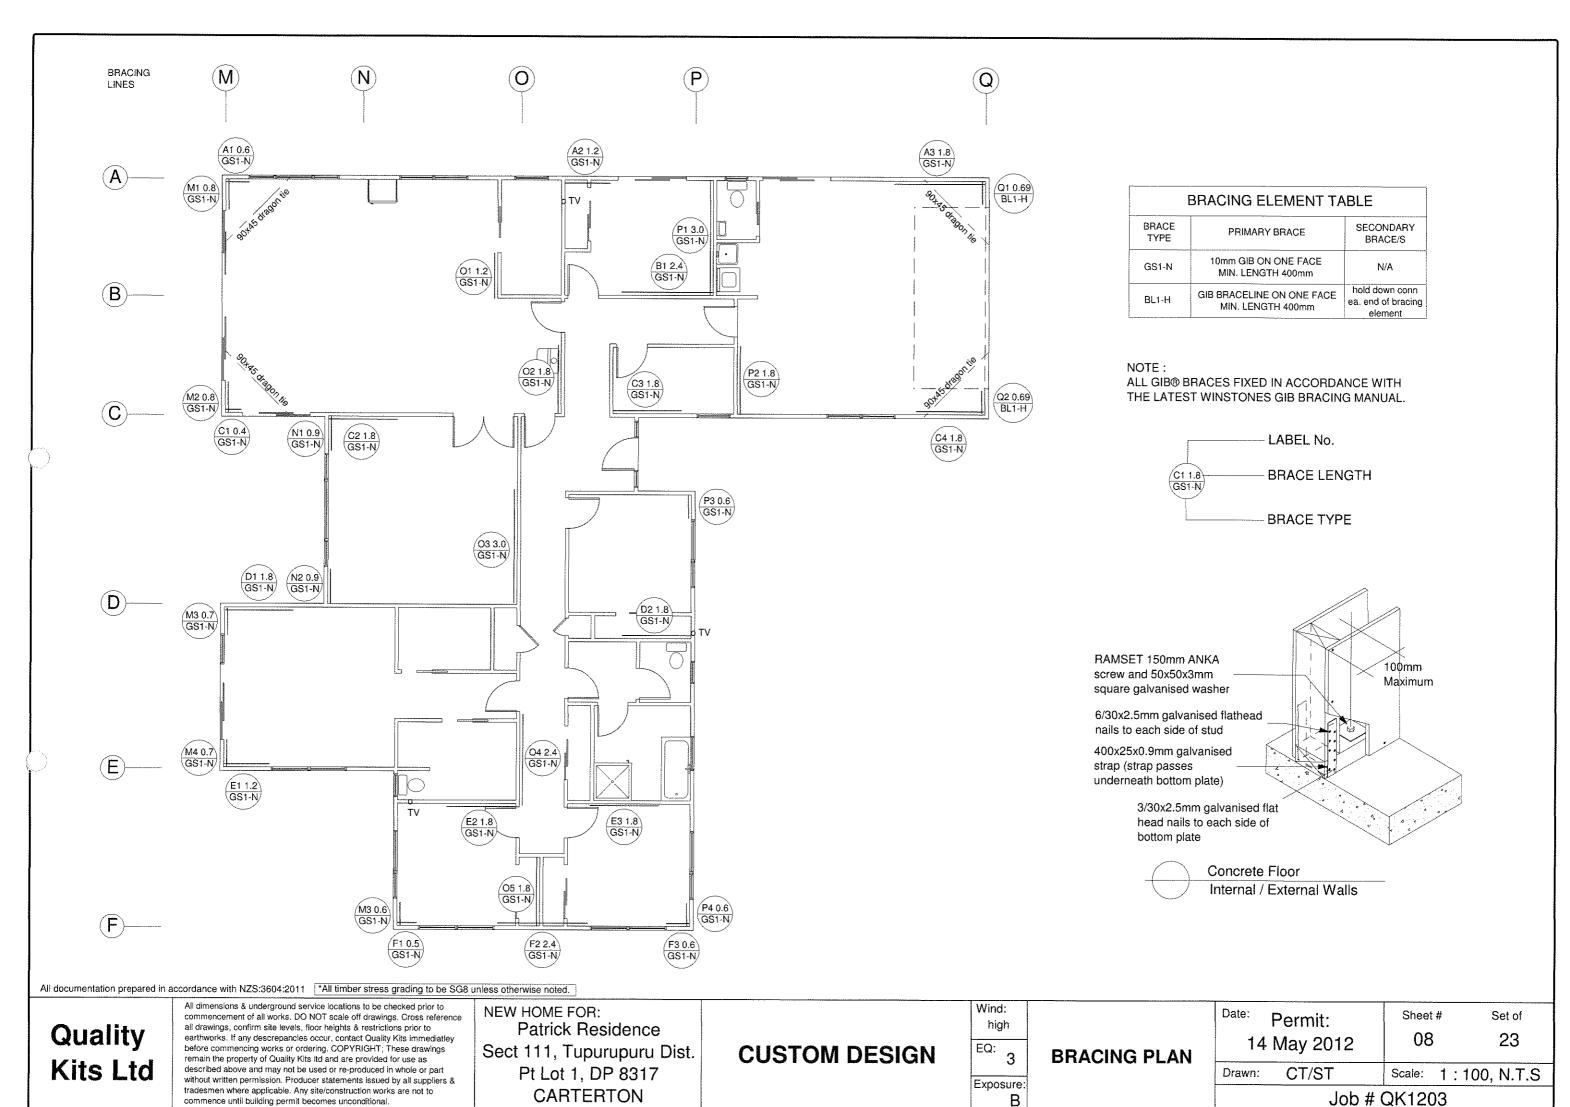
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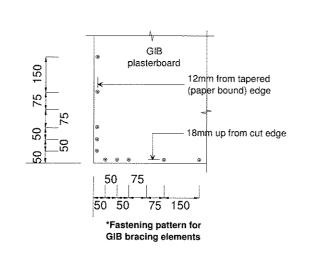
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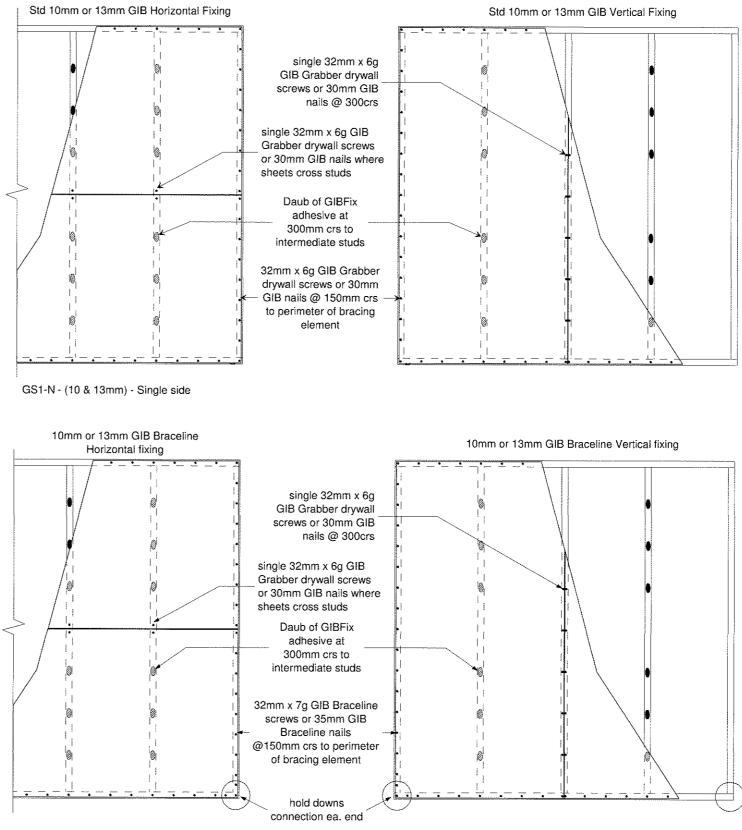
**FOUNDATION PLAN** 

Date: <b>14</b>	Permit: May 2012	Sheet #	Set of <b>23</b>
Drawn:	CT/ST	Scale:	1:100

Job # QK1203







BL1-H - (10 & 13mm) Single side only, min Length 0.4m.

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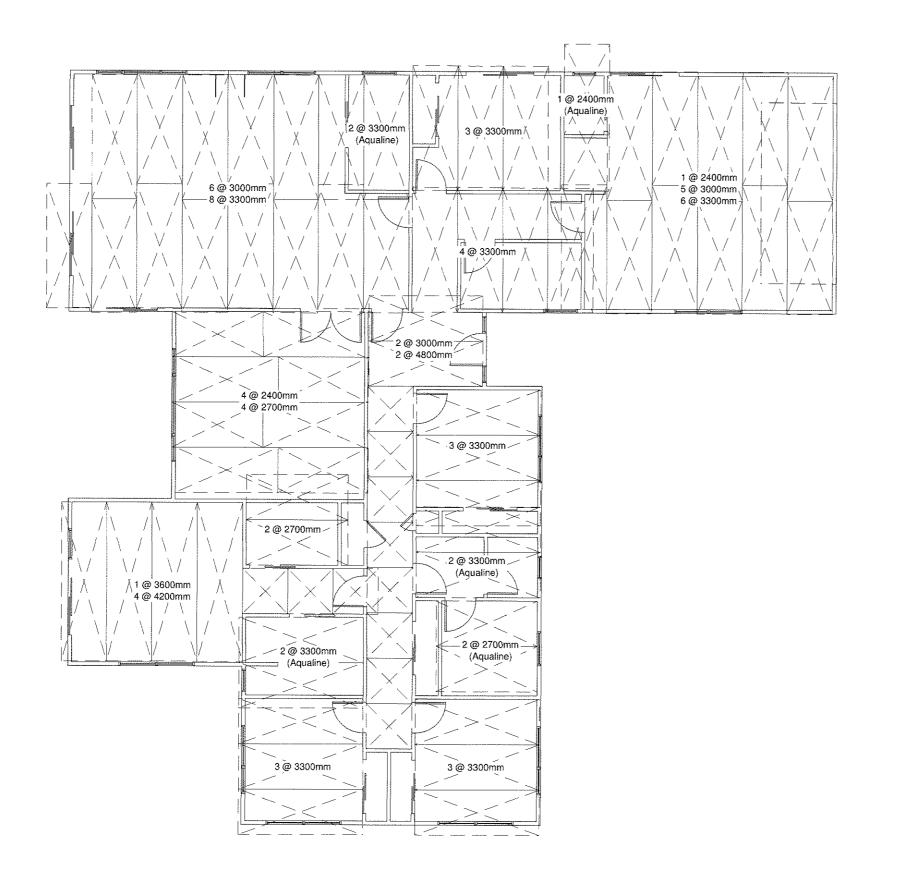
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GIB BRACE FIXING DETAILS 
 Date:
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 23

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 Job # QK1203



NOTE:

GIB BOARD - CEILINGS

All ceiling areas not indicated by sheet sizes shall be filled with standard 2400x1200x10mm Gib Board.

All Gib Board to be at right angles (lengthways) to the ceiling strapping.

Allow to stagger sheet ends as shown here.

Back blocking as per Gib Board Standard Detais. Do not join over support.

Commence fixing from centre of sheet outwards.

Do not place adhesive at sheet perimeters or under fixings.

Use 32mm Gib grabber screws fixed 12mm from sheet edges and at 200 mm centres to wall ends of Gib Board.

To all intermediate supports allow 32mm Gib grabber screws at each batten along Gib Board centre line and sheet edges. Allow 25x10mm daubs of Gib Fix Adhesive at 200mm crs. between fixings.

NOTE:

GIB BOARD - WALLS

Wall Gib to be vertically fixed - 2400x1200x10mm Standard Gib Board. Fix with 30mm Gib clouts at 300mm centres to perimeter of sheets. Allow 25x10mm daubs of Gib Fix adhesive to all intermediate supports.

Do not place adhesive at sheet perimeters or under clouts.

TALLY GIB BOARD CEILINGS

6 @ 2400mm (1/Aqualine) 8 @ 2700mm (2/Aqualine)

13 @ 3000mm 35 @ 3300mm (6/Aqualine)

1 @ 3600mm 4 @ 4200mm (4/Aqualine)

2 @ 4800mm

### REFLECTIVE CEILING PLAN

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CUSTOM DESIGN

Wind:
high

EQ:
3


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REFLECTED CEILING PLAN

 Date:
 Permit:
 Sheet #
 Set of

 14 May 2012
 10
 23

 Drawn:
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 1:100

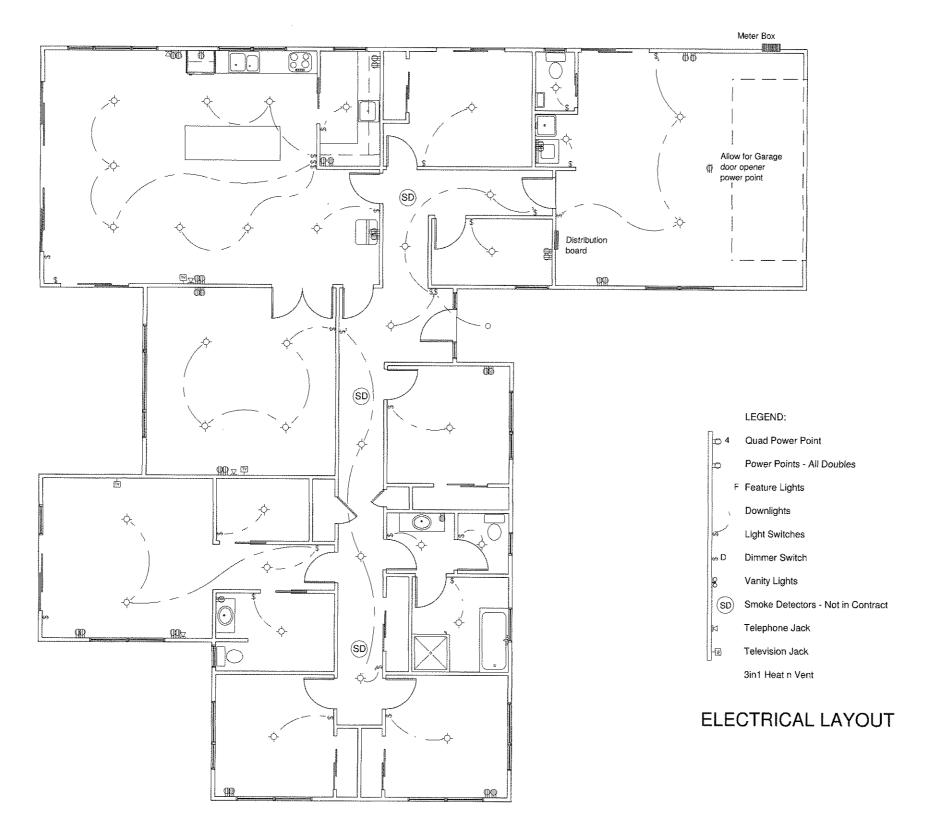

GENERAL NOTES:

All electrical work & items to comply with; NZBC F7/AS1, AS/NZS 3000, AS/NZS 3008,

Confirm final positioning & fitting allowance with client contract specifications.

(SD)- first alert or similar.

Approved smoke alarms are required within 3.0m of any sleeping space door. Smoke alarms must be audible to sleeping occupants on the other side of closed doors. Smoke alarms shall also be located on escape routes within the household.

All downlighting to be CA Rated to comply with NZBC: H1/AS1 energy efficiency.

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**CUSTOM DESIGN** 


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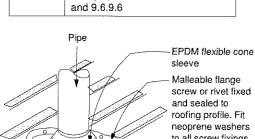
**ELECTRICAL LAYOUT** 

Sheet # Permit: 14 May 2012 11 CT/ST Drawn: Scale: 1:100

Job # QK1203

Set of



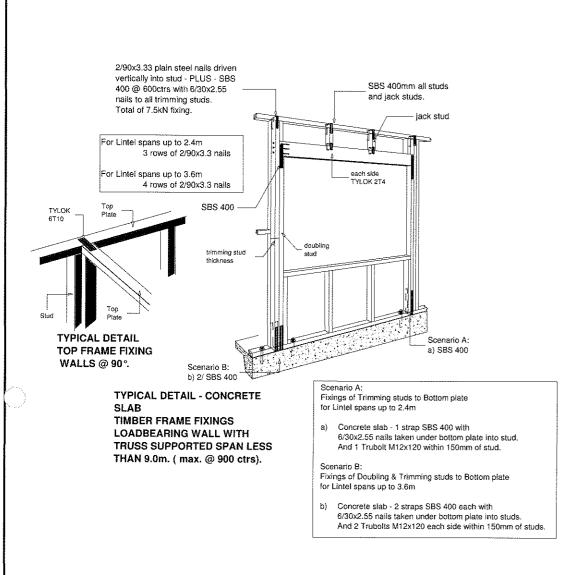


Paragraph 8.3.10, 8.4.17a 9.6.8.5


Figure 53: Flashing for small pipes

roofing profile. Fit neoprene washers to all screw fixings. Flashing fixed diagonally to roofling proffle to minimise holding of discharge water. (1) Max roof pitch for this flashing 45°, minimum pitch 10°.

(2) For pipes up to 60mm diameter

STUD TO TOP PLATE FIXING DETAILS

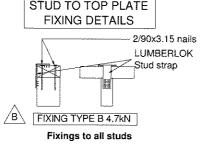

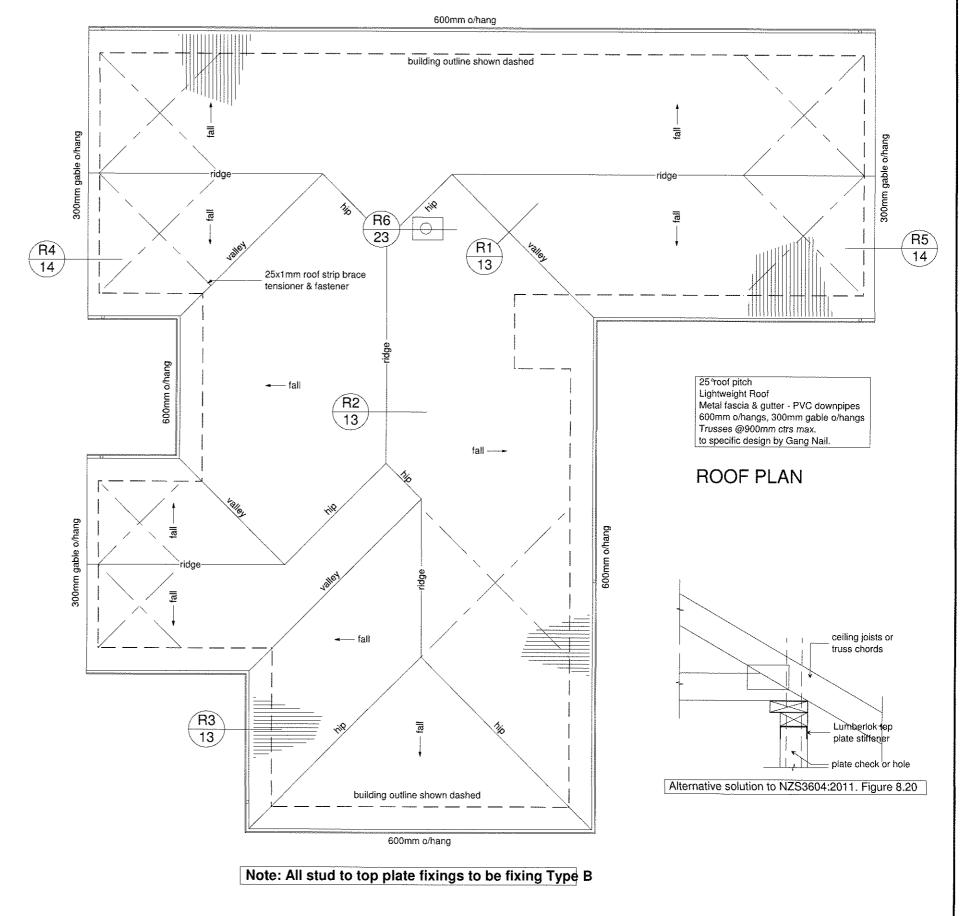

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**NEW HOME FOR:** Patrick Residence Sect 111, Tupurupuru Dist. Pt Lot 1, DP 8317 **CARTERTON** 

**CUSTOM DESIGN** 

Wind: high EQ: Exposure

**ROOF PLAN** & ROOF **DETAILS** 


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Job # QK1203


23

### Roof Space Brace Installation

(A) Roof Space Brace - less than 2m long.

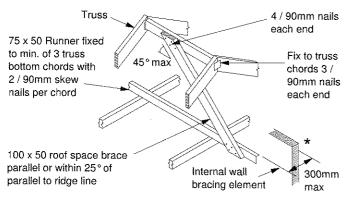


(B) Roof Space Brace - more than 2m long.

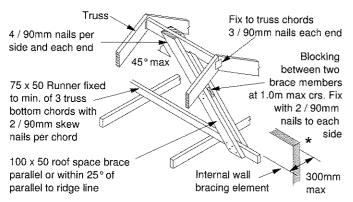


(C) Roof Space Brace - not directly under the ridge - less than 2m long. 4 / 90mm nails each end 75 x 50 Runner fixed to min. of 3 truss 3 / 90mm nails bottom chords with each end 2 / 90mm skew nails per chord 100 x 50 roof space brace parallel or within 25° of parallel to ridge line bracing element (D) Roof Space Brace - not directly under the

ridge - more than 2m long. 4 / 90mm nails per 3 / 90mm nails each end side and each end 75 x 50 Runner fixed 100 x 50 roof space 45° max to min. of 3 truss brace parallel or bottom chords with within 25° of parallel to ridge line nails per chord Blocking between two brace members a5 1.0m max crs. Fix with 2 / 90mm nails to each side bracing element

\* Not required when a ceiling diaphragm complying with clause 13.5 NZS 3604:2011 is used.

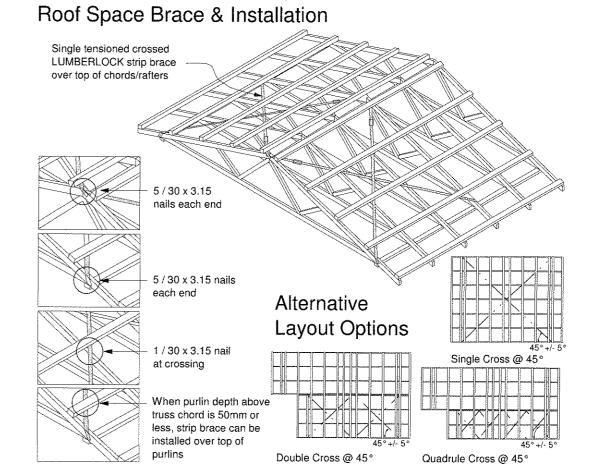

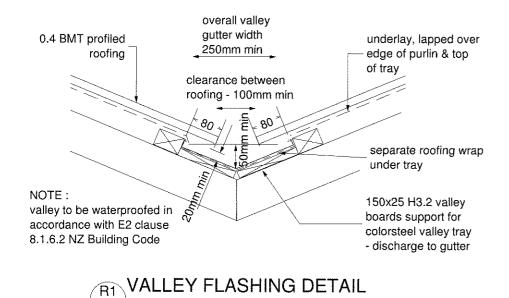

c/steel ridge flashing screw fixing 0.4 BMT longrun roofing

RIDGE FLASHING DETAIL

Metal Fascia & spouting.
100x50 ribbon board and soffit framing. 4.5mm
Hardiflex soffit lining

H3.1 pp soffit mould

JH weatherboard exterior cladding

R3 SOFFIT DETAIL

600mm o/h

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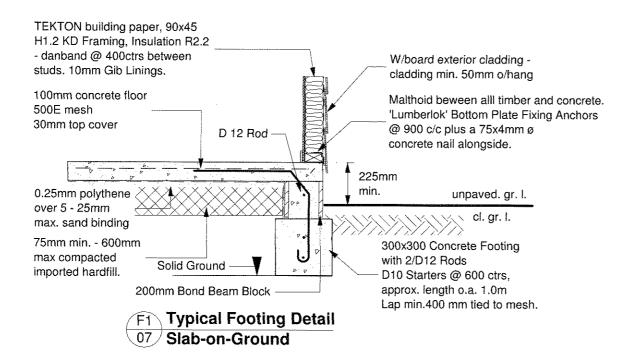
NEW HOME FOR:
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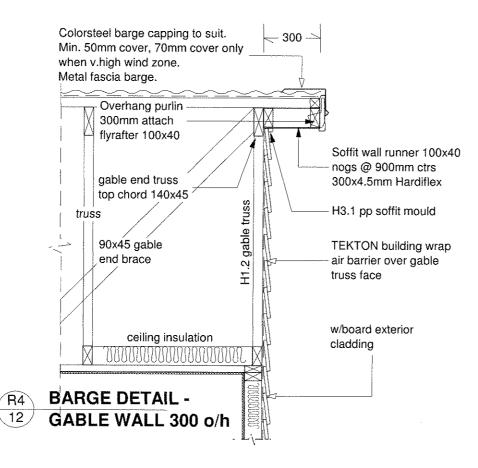
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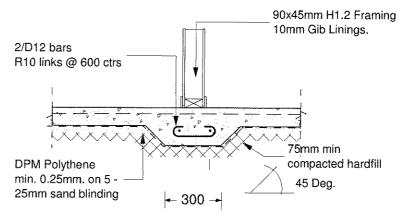
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ROOF CONSTRUCTION DETAILS

Permit: 14 May 2012		Sheet#	Set of 23
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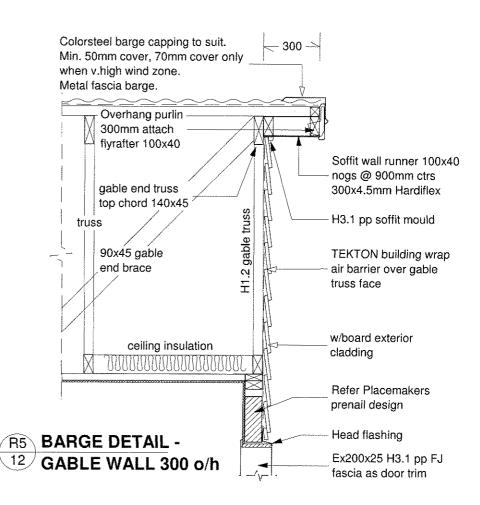






Malthoid beween ALL timber and concrete.

Pad thickening under internal loadbearing walls (if required)



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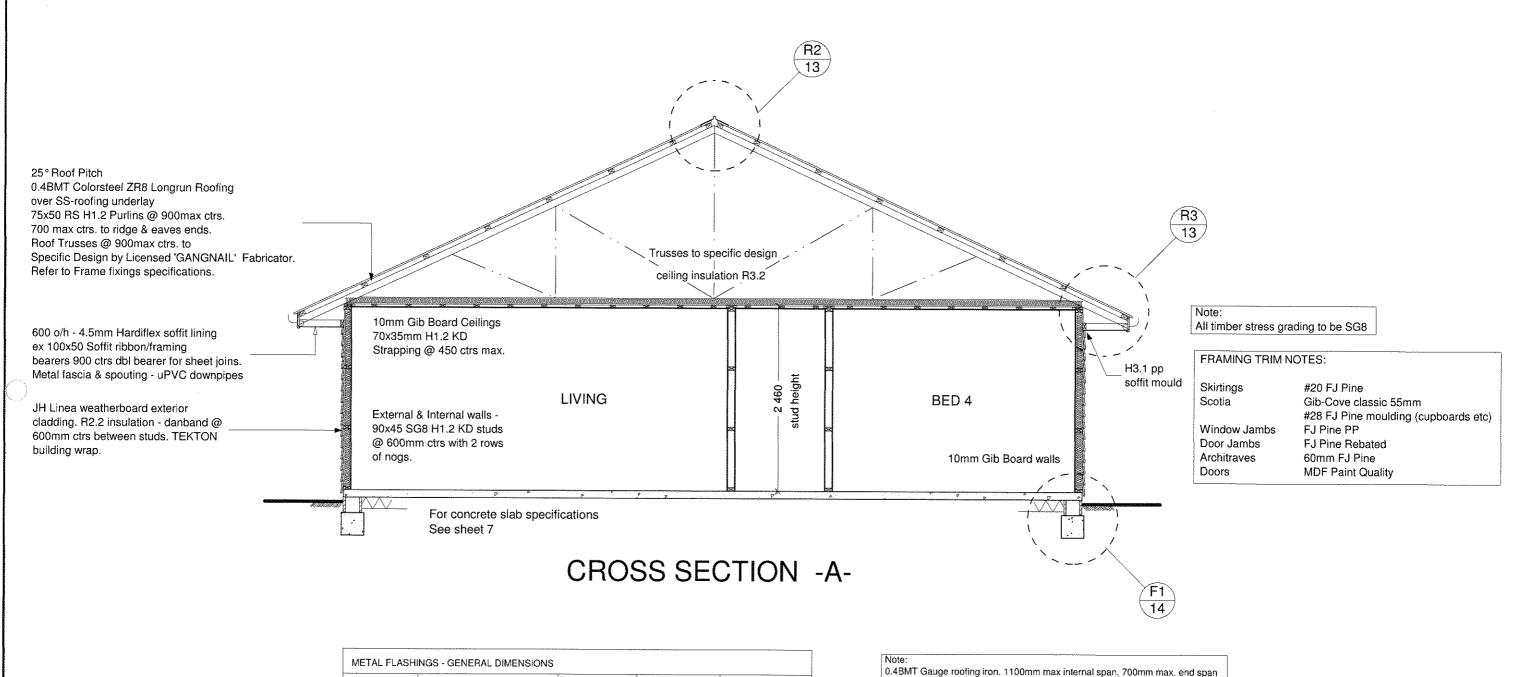
**CUSTOM DESIGN** 

Wind: high
EQ:
Exposure:

В

# CONSTRUCTION DETAILS

Date:	Permit: May 2012	Sheet #	Set of 23
Drawn:	CT/ST	Scale:	1:20
	Job # (	QK1203	



METAL FLASH	HINGS - GENERAL DIMENSIONS	3		****
TYPE	DESCRIPTION	ALL	SITUATION 1	SITUATION 2
Aprons: general	Transverse flashing over		(130mm)	200mm
general	roofing. Parallel flashing over.		Two crests, finish	in next trough
Ridges/ hips	Transverse flashing over roofing.		Refer to Aprons: general	
Changes in roof pitches	Upper lap under roofing.	250mm		
roor phones	Transverse flashing over roofing.	All son de sans	Refer to Aprons:	general
Barges	Overlap to barge board.		(50mm)	70mm
				-

0.4BMT Gauge roofing iron. 1100mm max internal span, 700mm max. end spa of roofing iron in accordance with NZBC E2/AS1 8.4.6 Structure Table 11. Fixings for corrugated profiles & spans as shown in table 11 shall be either; i) A 3.8mm min. ø spiral shank nail hot dipped galv to AS/NZS 4680, or ii) A min. 12 gauge screw, which complies with Class 4 of AS 3566:Part 2.

### Roof fixings:

Roofing & flashings fixed with 12 Gauge Hex head roofing screws with Neoprene sealing washers. Ridge, hip, valley, gutter & periphery roof areas; Fix side laps & every second corrugation. Remainder of roof; Fix side laps - miss 2, hit 1. Fixing pattern as shown in table 14 shall be:

- a) Be fixed through crests,
- b) Penetrate purlins by a min. of 40mm for nail fixings & 25mm for screw fixings,
   c) Include sealing washers of;
- i) Neoprene (having a carbon black content of 15% or less by weight),
- ii) profiled washer & EPDM washer where required to allow for expansion of the profiled metal roof cladding.

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NEW HOME FOR:
Patrick Residence
Sect 111, Tupurupuru Dist.
Pt Lot 1, DP 8317
CARTERTON

## **CUSTOM DESIGN**


Wind:
high

EQ:
3

Exposure:

# CROSS SECTION -A-

Date:	Permit:	Sheet #	Set of
14 May 2012		15	23
Drawn:	CT/ST	Scale:	1:50
	Job #	QK1203	

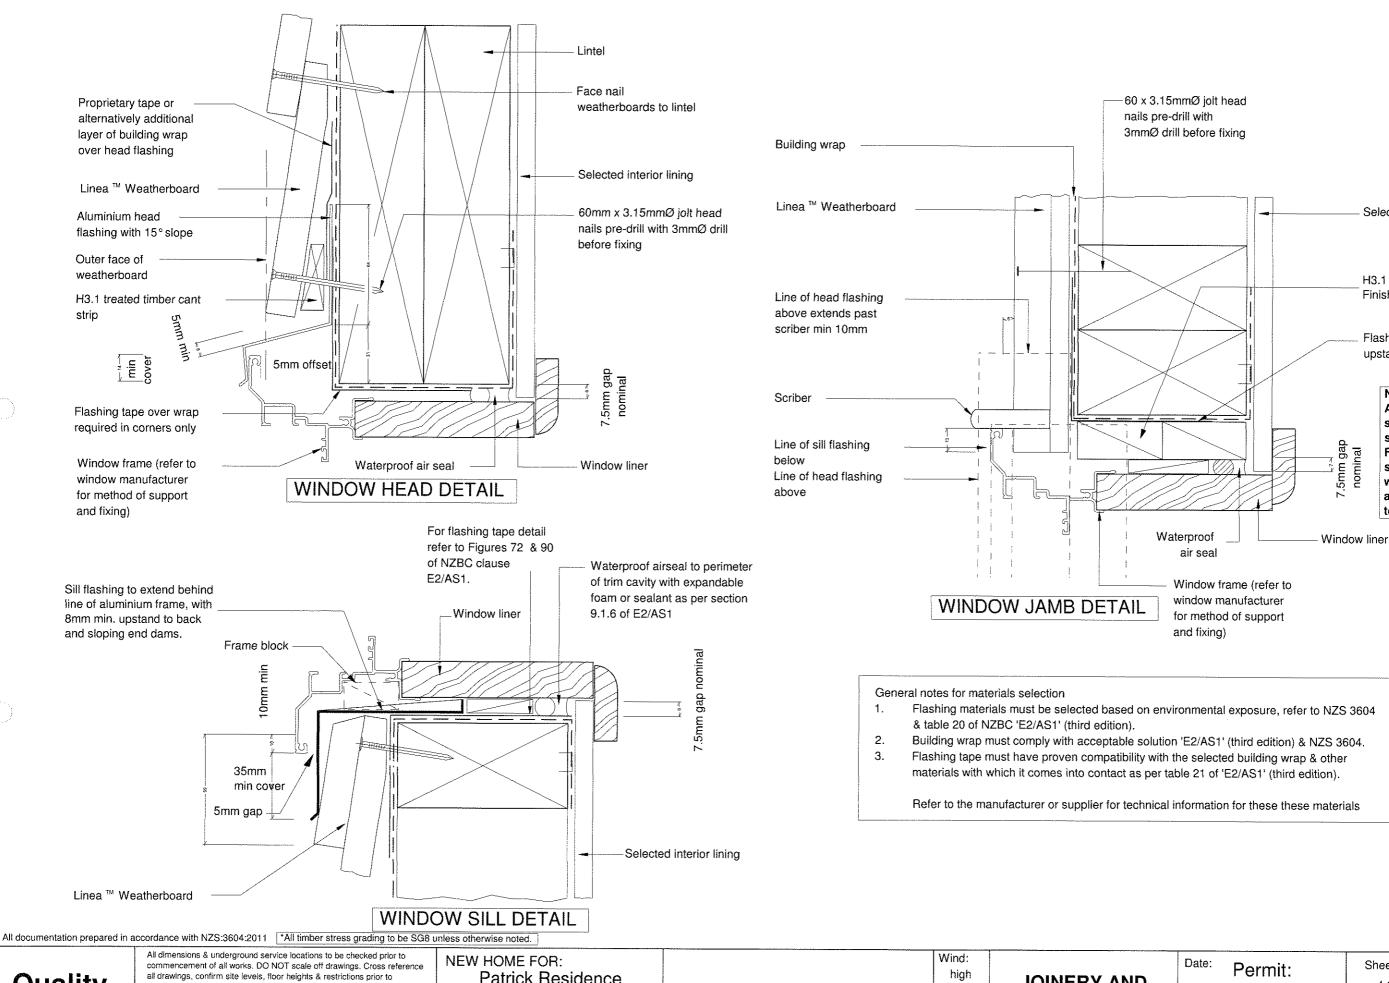

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Patrick Residence
Sect 111, Tupurupuru Dist.
Pt Lot 1, DP 8317
CARTERTON

**CUSTOM DESIGN** 

high
EQ:
3
Exposure:

JOINERY AND CLADDING DETAILS 
 Date:
 Permit:
 Sheet #
 Set of

 14 May 2012
 16
 23

 Drawn:
 CT/ST
 Scale:
 1:2

Selected interior lining

H3.1 20mm battens. Finish clear of sill flashing.

Flashing tape 100mm upstand on jamb

Aluminium joinery

sizing as noted on

aluminium box size

sizes to be box


Floor plan. Trim

sizing to 55mm


to all openings.

wider than

Note:

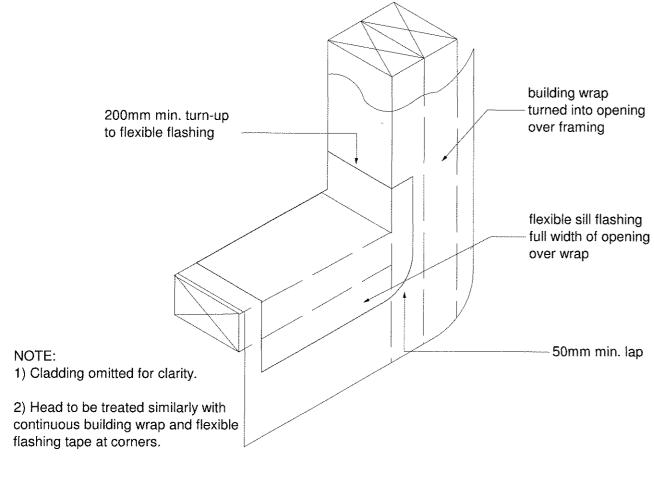

DETAIL GENERAL WINDOW OPENING FOR DIRECT FIX WALL CLADDINGS WANZ INSTALLATION SYSTEM

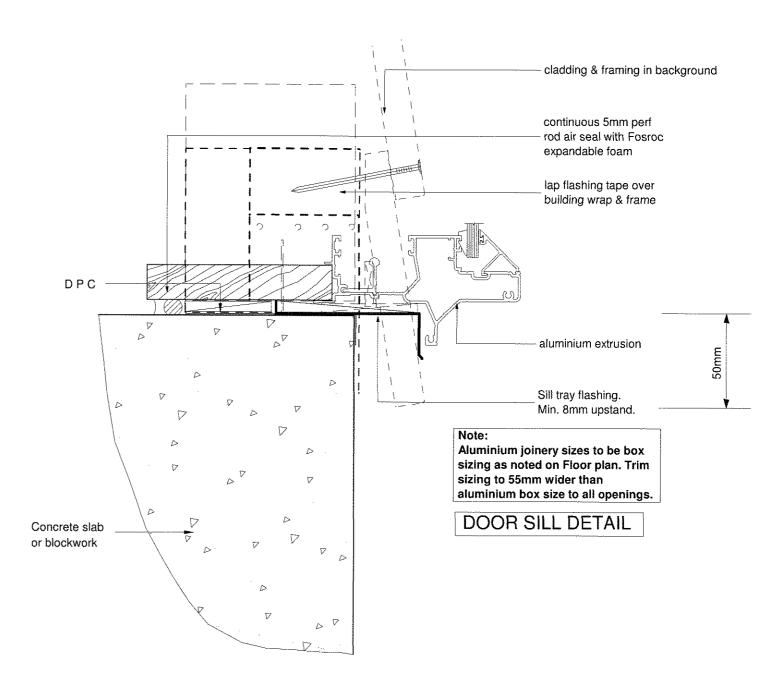

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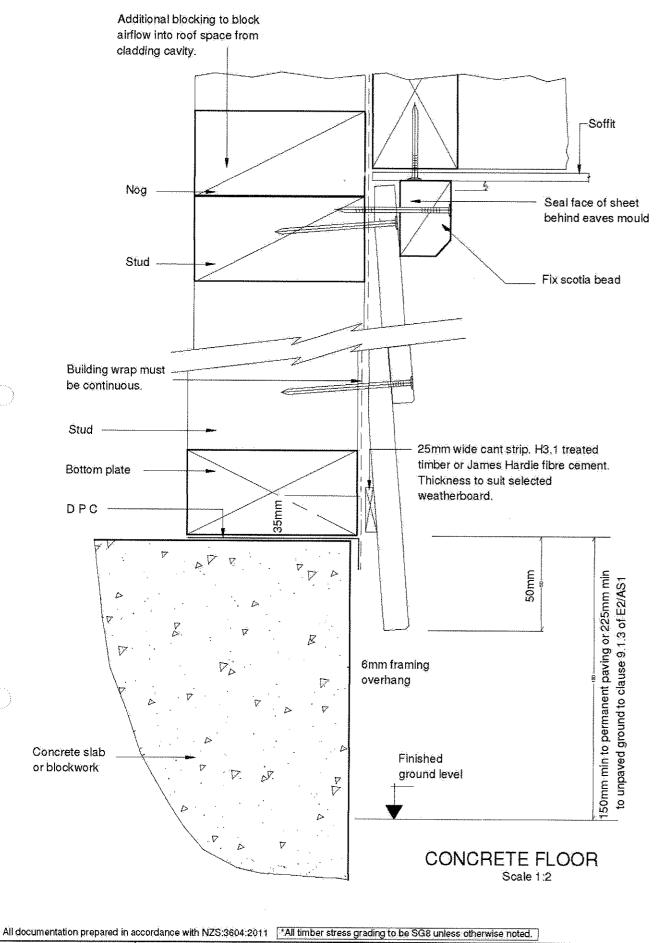
NEW HOME FOR:
Patrick Residence
Sect 111, Tupurupuru Dist.
Pt Lot 1, DP 8317
CARTERTON


CUSTOM DESIGN

high	
EQ: 3	
Exposure:	
	EQ:

DOOR SILL DETAILS


Date:	Permit:	Sheet #	Set of
14 May 2012		17	23
Drawn:	CT/ST	Scale: 1:	2, N.T.S



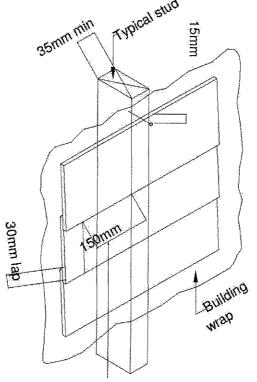

Concealed back soaker join in weatherboard to be 150mm minimum from side of stud.

Joints must be staggered by 600mm minimum

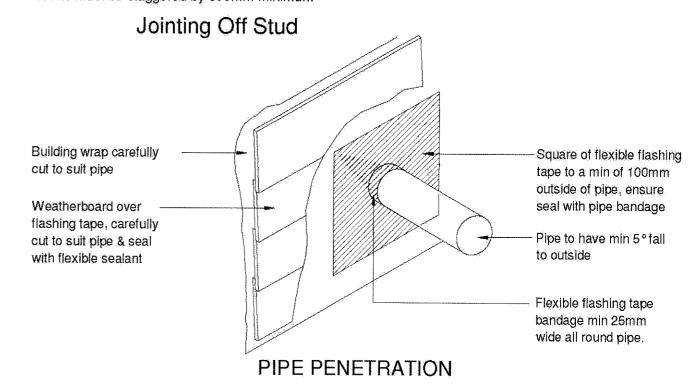

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Patrick Residence
Sect 111, Tupurupuru Dist.
Pt Lot 1, DP 8317
CARTERTON


**CUSTOM DESIGN** 

Wind	i:
hig	jh
EQ:	3
Expo	sure

В

CLADDING DETAILS

	Permit:	Sheet #	Set of
	May 2012		23
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**DIRECT FIX INTERNAL CORNER** 

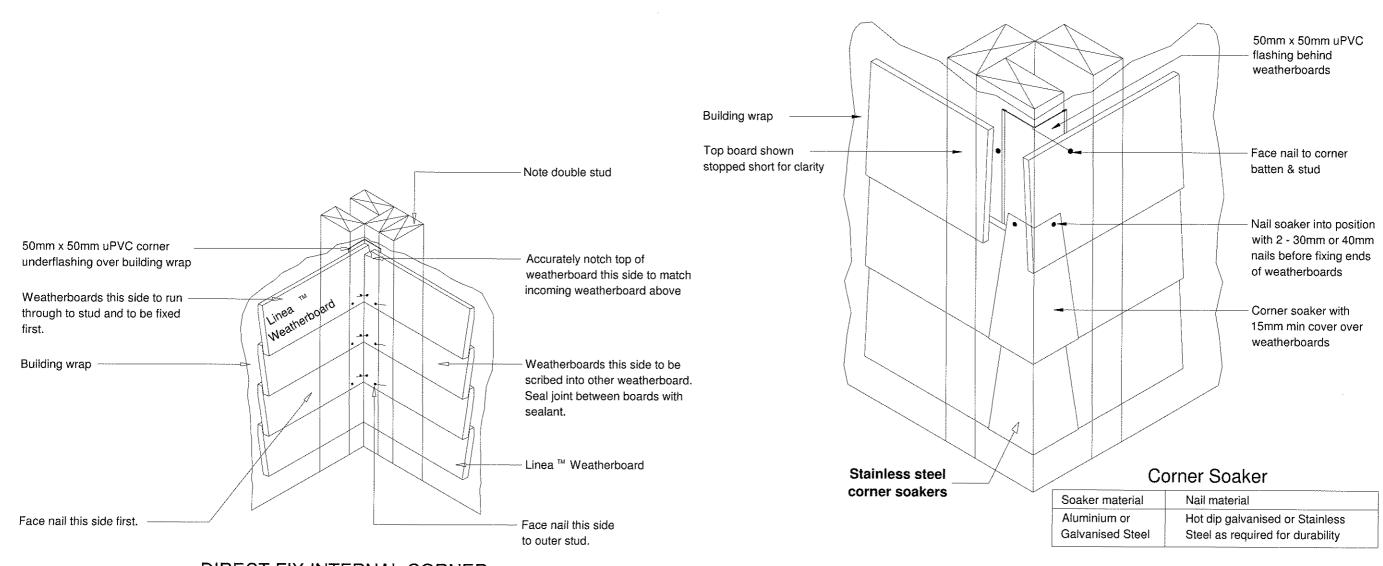Scale 1:10

DIRECT FIX EXTERNAL CORNER SOAKER

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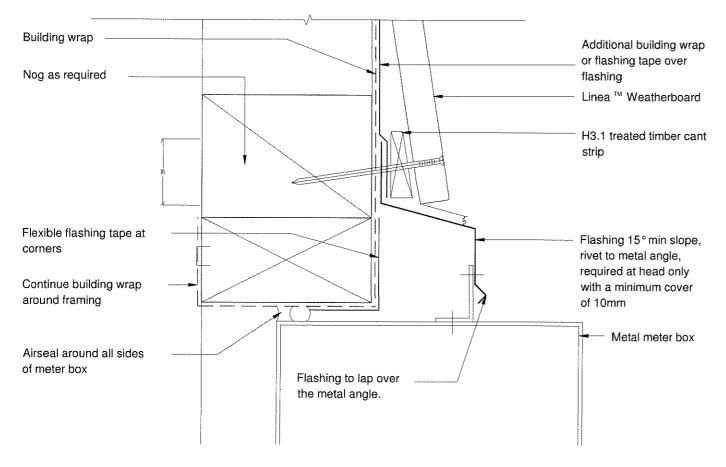
NEW HOME FOR:
Patrick Residence
Sect 111, Tupurupuru Dist.
Pt Lot 1, DP 8317
CARTERTON

CUSTOM DESIGN

Wind:	
hig	gh
EQ:	3
Ехро	sure

CLADDING DETAILS

<sup>Date:</sup> Permit:		Sheet #	Set of
14	May 2012	19	23
Orawn:	CT/ST	Scale: 1:2	2, N.T.S



## DIRECT FIX METER BOX AT HEAD Scale 1:2

Metal angle to be sealed and riveted in place.


Flexible flashing tape at corners

Airseal around all sides of meter box

Continuous sealant to metal angle

Continue building wrap around framing

Building wrap

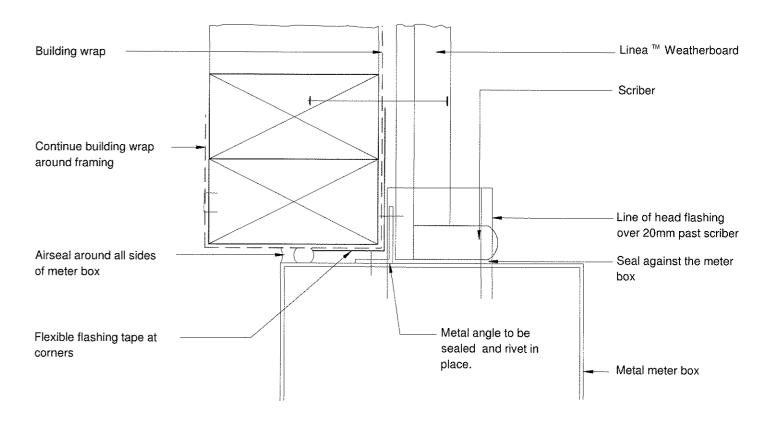

DIRECT FIX METER BOX AT JAMB

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Patrick Residence
Sect 111, Tupurupuru Dist.
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CARTERTON


CUSTOM DESIGN


Linea ™ Weatherboard

Wind: high	
EQ: 3	
Exposure:	

METERBOX DETAILS

Date: Permit: 14 May 2012		Sheet #	Set of
		20	23
Drawn:	CT/ST	Scale:	1:2
	Job #	QK1203	

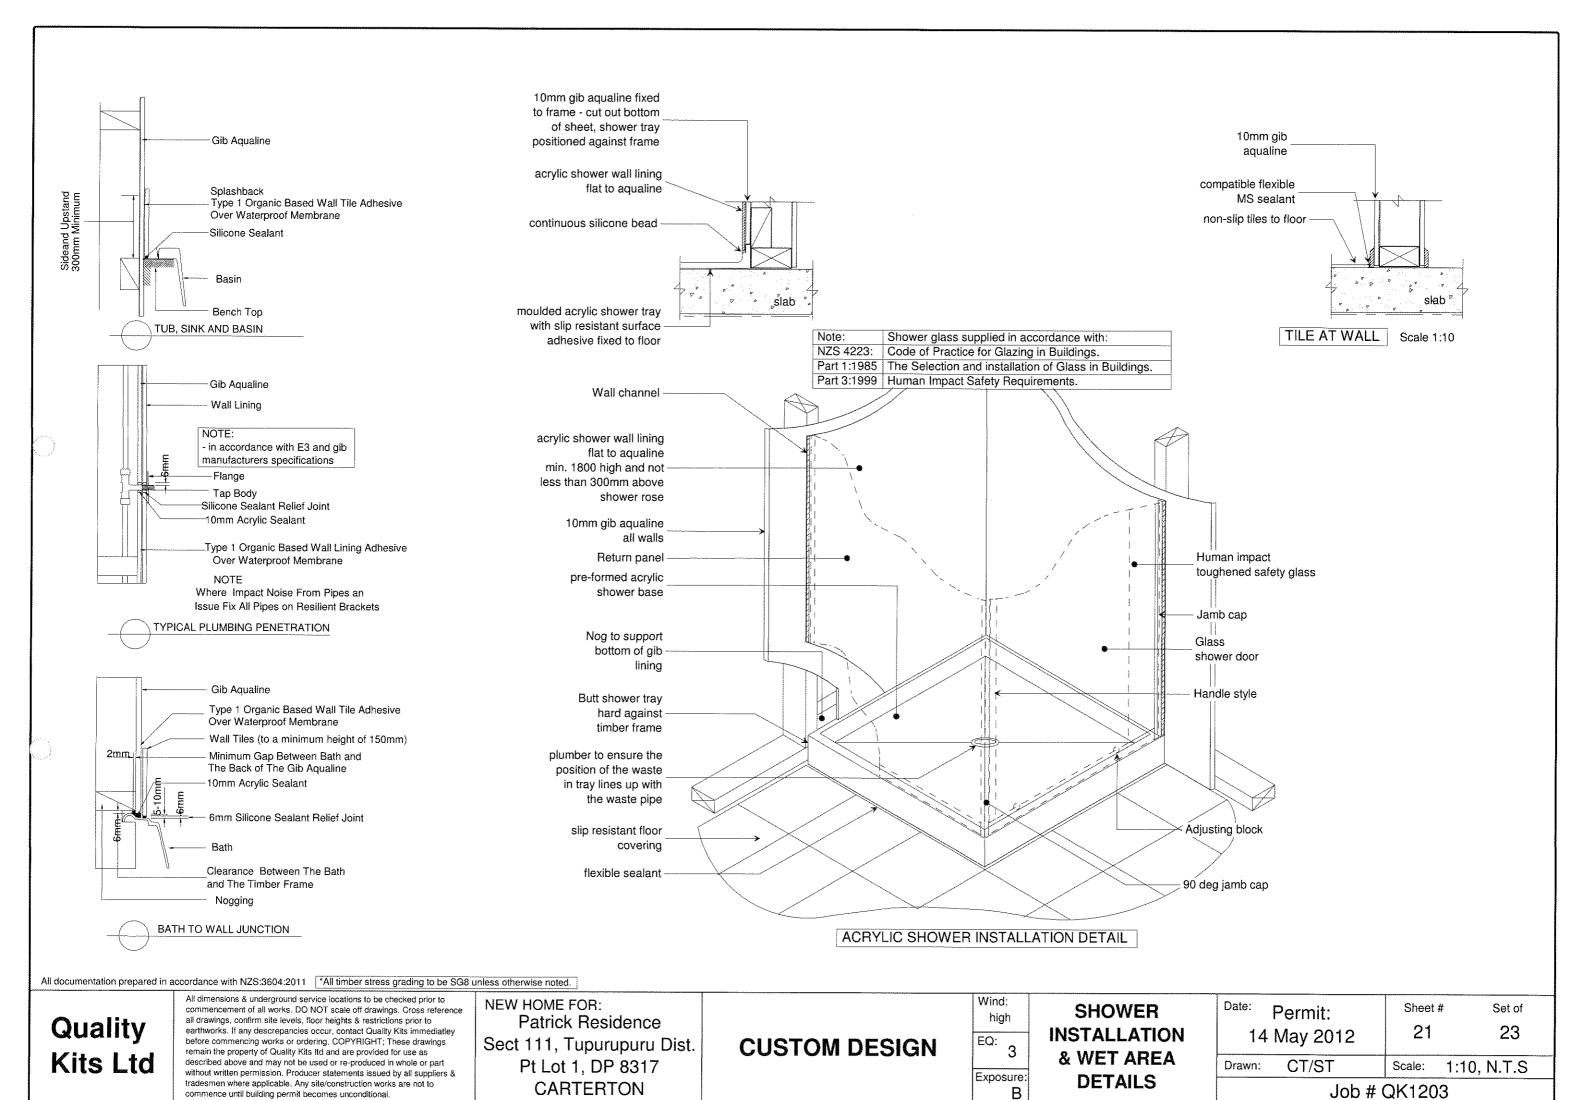

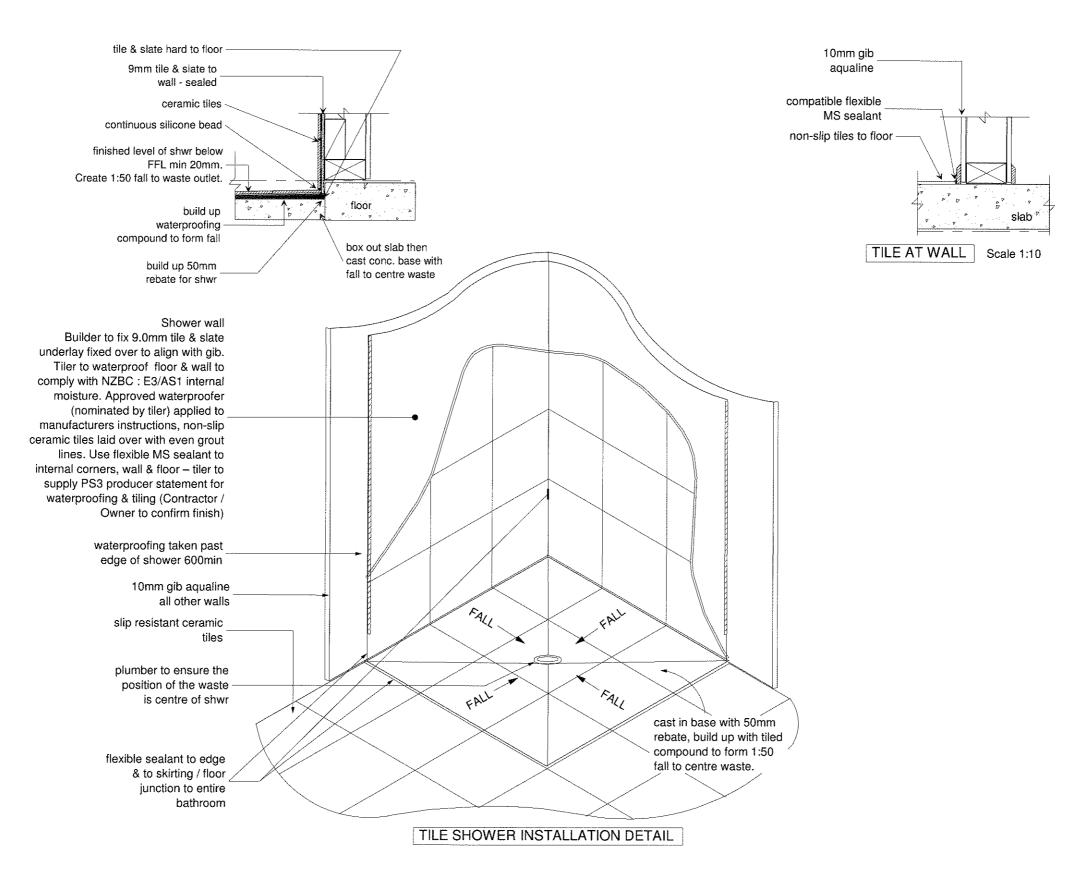

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NEW HOME FOR:
Patrick Residence
Sect 111, Tupurupuru Dist.
Pt Lot 1, DP 8317
CARTERTON

**CUSTOM DESIGN** 

Wind: high	
EQ:	
Exposure:	


SHOWER
INSTALLATION
& WET AREA
DETAILS


 Date:
 Permit:
 Sheet #
 Set of


 14 May 2012
 22
 23

 Drawn:
 CT/ST
 Scale:
 1:10, N.T.S

 Job # QK1203

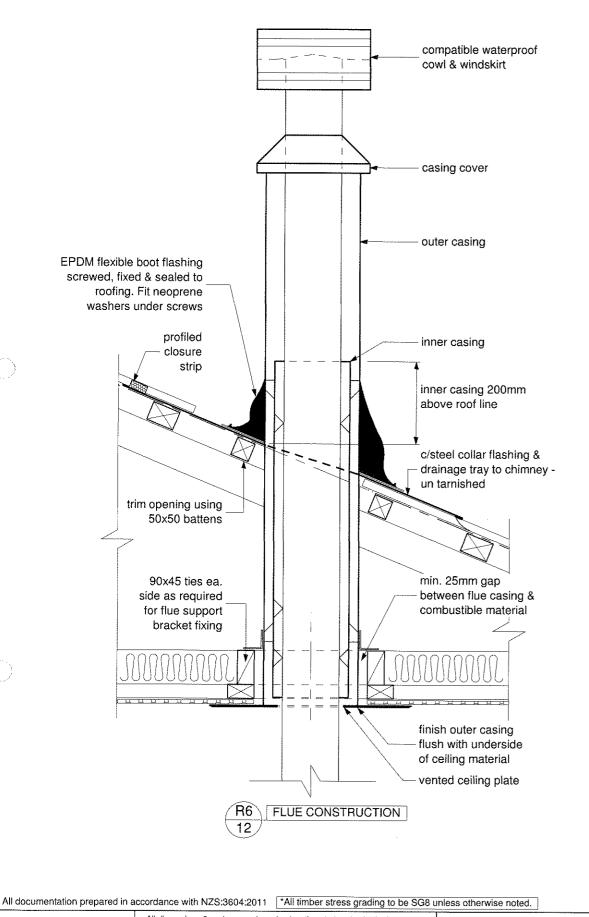

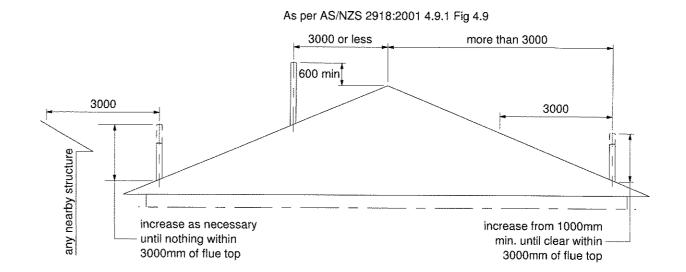

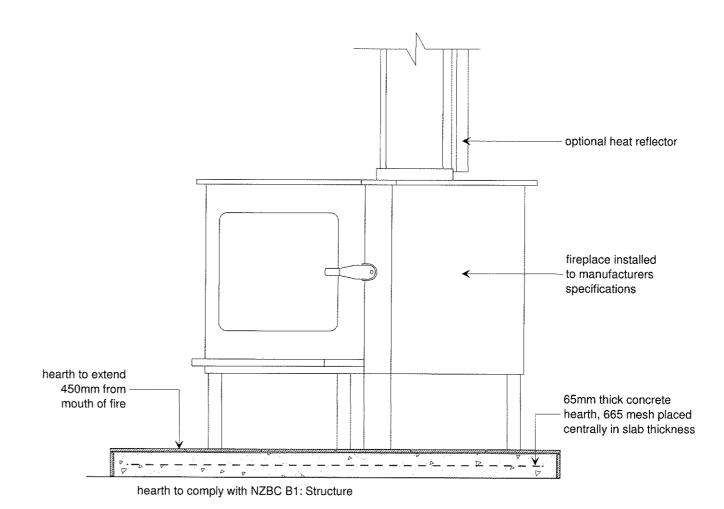

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**NEW HOME FOR:** Patrick Residence Sect 111, Tupurupuru Dist. Pt Lot 1, DP 8317 **CARTERTON** 

**CUSTOM DESIGN** 

Wind: high EQ: 3 Exposure: В

**FIREPLACE CONSTRUCTION DETAILS** 

Sheet # Set of Permit: 23 23 14 May 2012 CT/ST Drawn: 1:10, 1:100 Scale: